1299 Tarrants Gap Rd, Wyangala, NSW 2808


DA for Change of Use



Title **COVER SHEET** Scale NTS

Revision **5**

Current Issue Date Monday, 18 November 2024

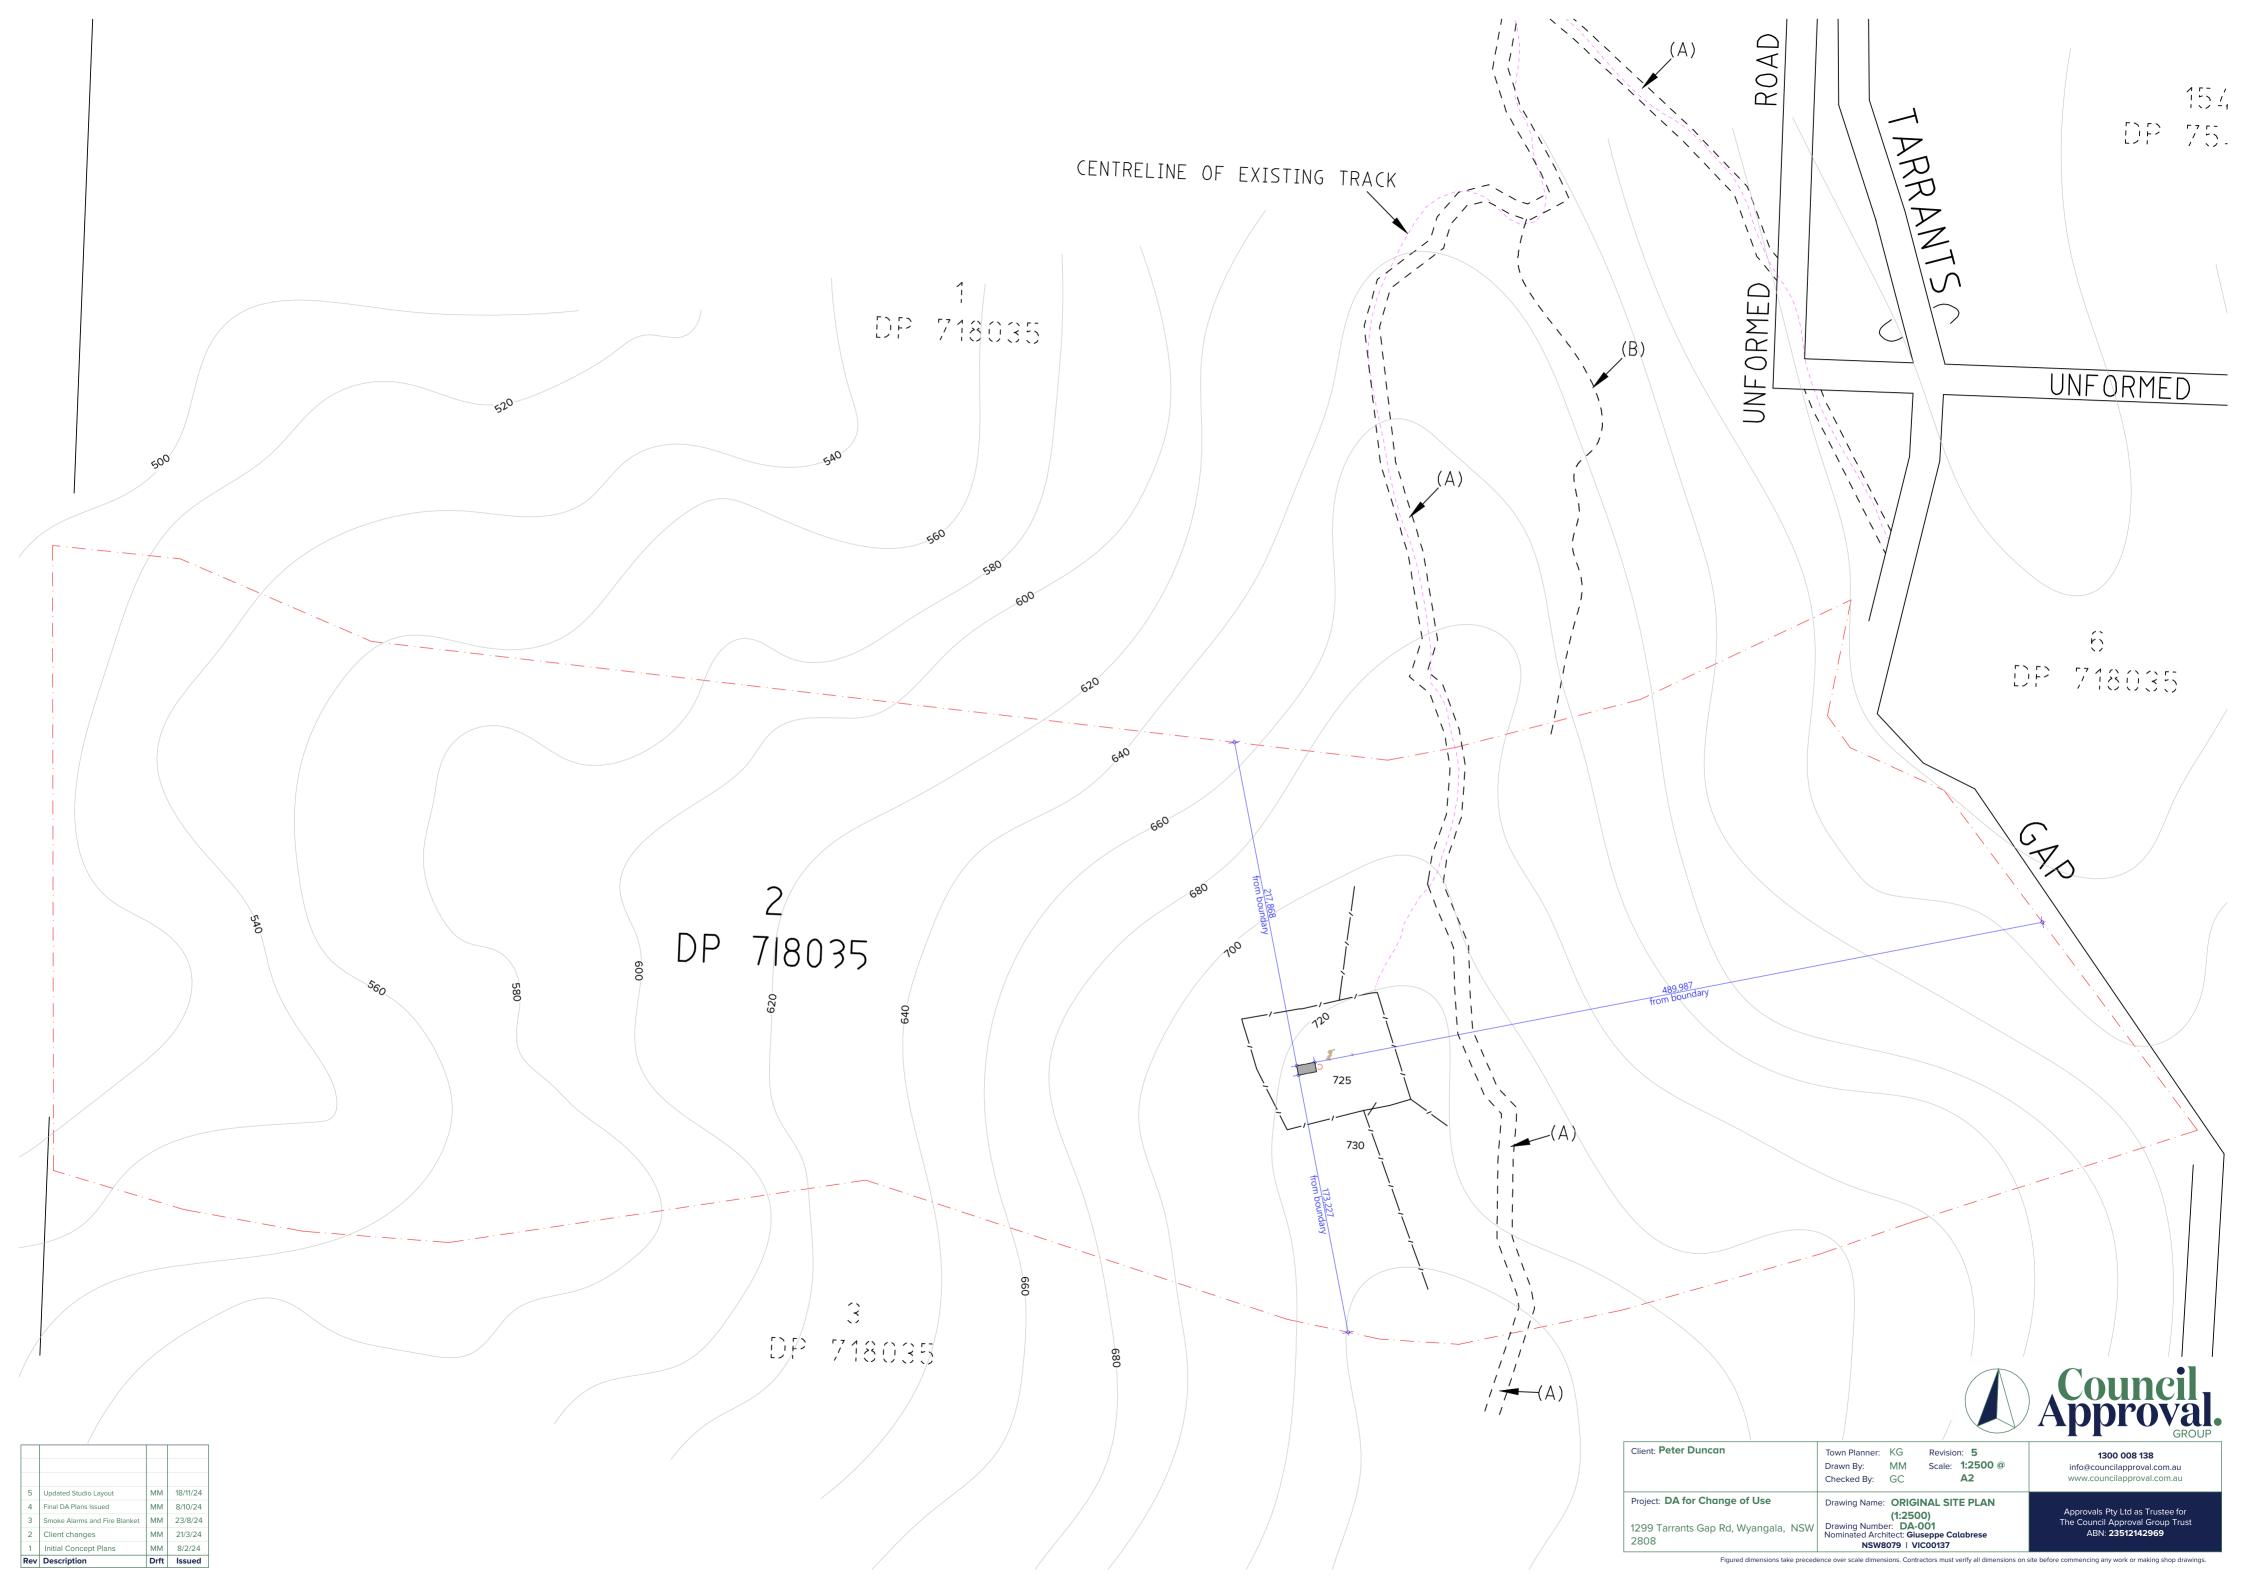









1300 008 138

info@councilapproval.com.au www.councilapproval.com.au

Client: Peter Duncan

Project: **DA for Change of Use**

1299 Tarrants Gap Rd, Wyangala, NSW 2808

Figured dimensions take precedence over scale dimensions. Contractors must verify all dimensions on site before commencing any work or making shop drawings.

Town Planner: KG Drawn By: MM

Revision: **5**Scale: **1:100** @ **A3**


Checked By: GC


Drawing Name: ORIGINAL FLOOR PLAN


Drawing Number: **DA-003**


Nominated Architect: Giuseppe Calabrese NSW8079 | VIC00137


> Approvals Pty Ltd as Trustee for The Council Approval Group Trust ABN: **23512142969**

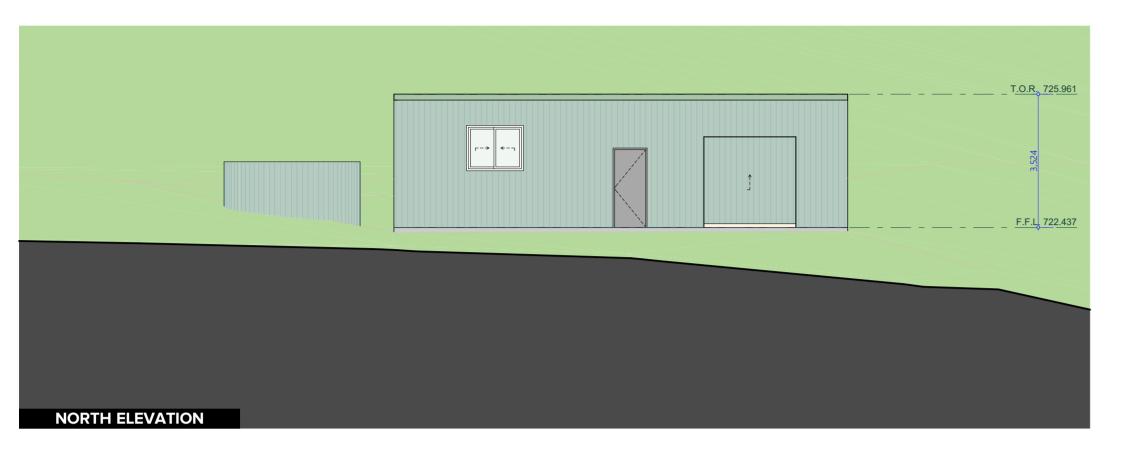

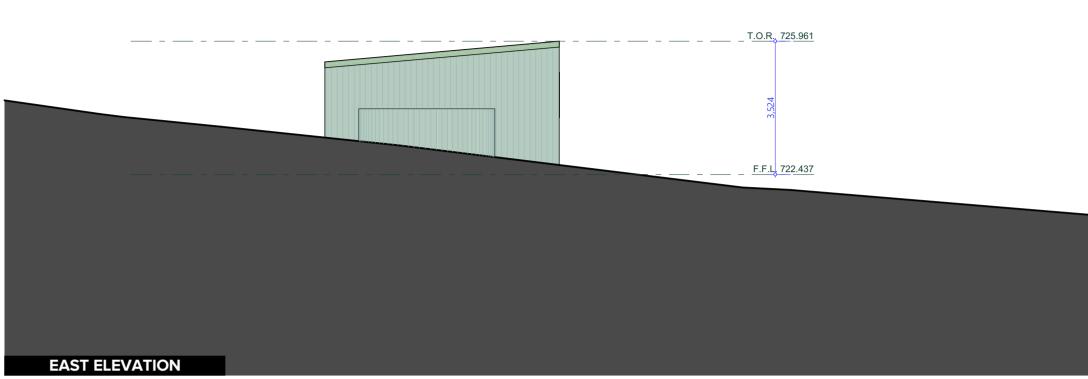

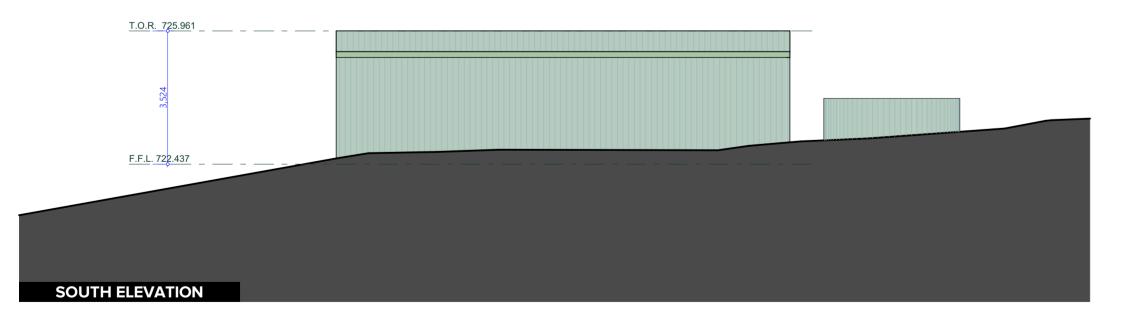


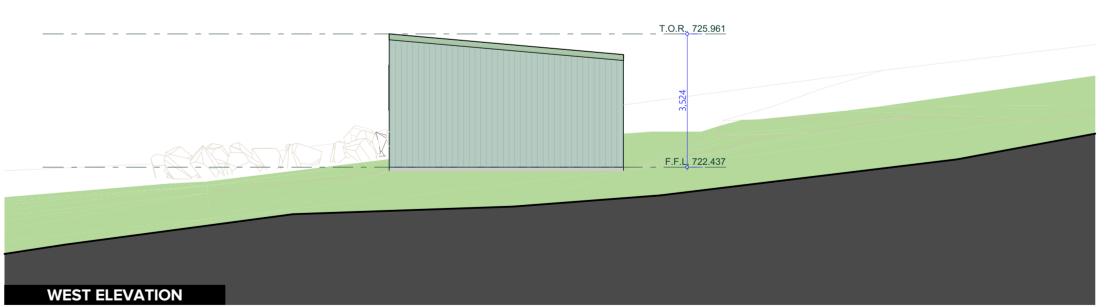


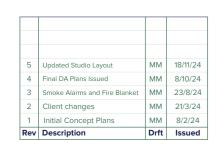

				Council Approval.
Client: Peter Duncan	Town Planner: Drawn By:	KG MM	Revision: 5 Scale: 1:100 @ A2	1300 008 138 info@councilapproval.com.au

Client: Peter Duncan	Town Planner: KG Revision: 5 Drawn By: MM Scale: 1:100 @ A2 Checked By: GC	1300 008 138 info@councilapproval.com.au www.councilapproval.com.au
Project: DA for Change of Use	Drawing Name: ORIGINAL ELEVATIONS	Approvals Pty Ltd as Trustee for
1299 Tarrants Gap Rd, Wyangala, NSW 2808	Drawing Number: DA-004 Nominated Architect: Giuseppe Calabrese	The Council Approval Group Trust ABN: 23512142969

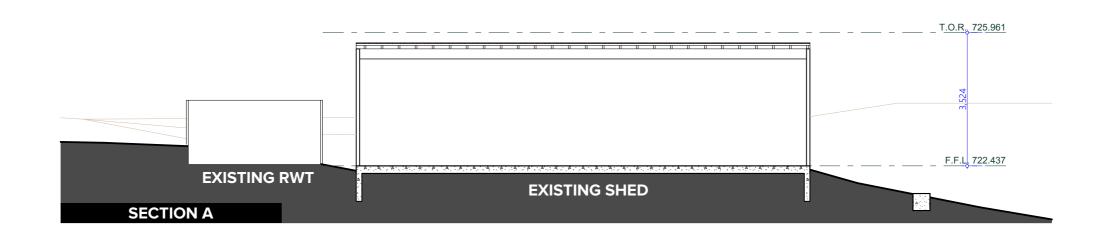

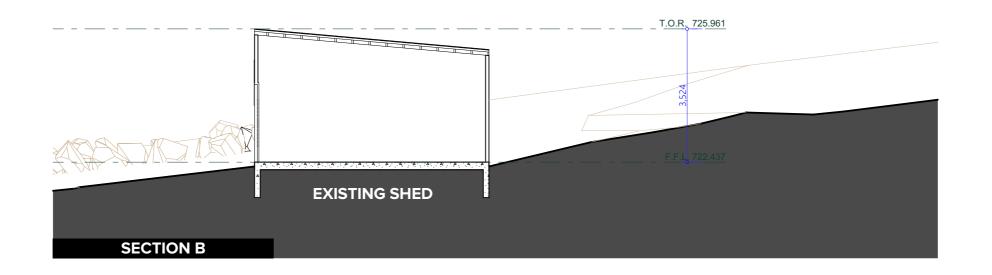




Client: Peter Duncan	Town Planner: KG Revision: 5 Drawn By: MM Scale: 1:100 @ A3 Checked By: GC	1300 008 138 info@councilapproval.com.au www.councilapproval.com.au
Project: DA for Change of Use	Drawing Name: ORIGINAL SECTIONS	Approvals Pty Ltd as Trustee for
1299 Tarrants Gap Rd, Wyangala, NSW 2808	Drawing Number: DA-005 Nominated Architect: Giuseppe Calabrese NSW8079 VIC00137	The Council Approval Group Trust ABN: 23512142969

Final DA Plans Issued Smoke Alarms and Fire Blanket Client changes Initial Concept Plans	MM MM MM	8/10/24 23/8/24 21/3/24 8/2/24
Smoke Alarms and Fire Blanket	MM	23/8/24
Final DA Plans Issued	MM	8/10/24
Updated Studio Layout	MM	18/11/24
	Updated Studio Layout	Updated Studio Layout MM






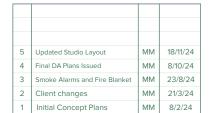



Drft Issued

Rev Description

		Council Approval.
Client: Peter Duncan	Town Planner: KG Revision: 5 Drawn By: MM Scale: 1:161.52 @ Checked By: GC A3	1300 008 138 info@councilapproval.com.au www.councilapproval.com.au
Project: DA for Change of Use 1299 Tarrants Gap Rd, Wyangala, NSW 2808	Drawing Name: ORIGINAL PERSPECTIVE Drawing Number: DA-006 Nominated Architect: Giuseppe Calabrese NSW8079 VIC00137	Approvals Pty Ltd as Trustee for The Council Approval Group Trust ABN: 23512142969

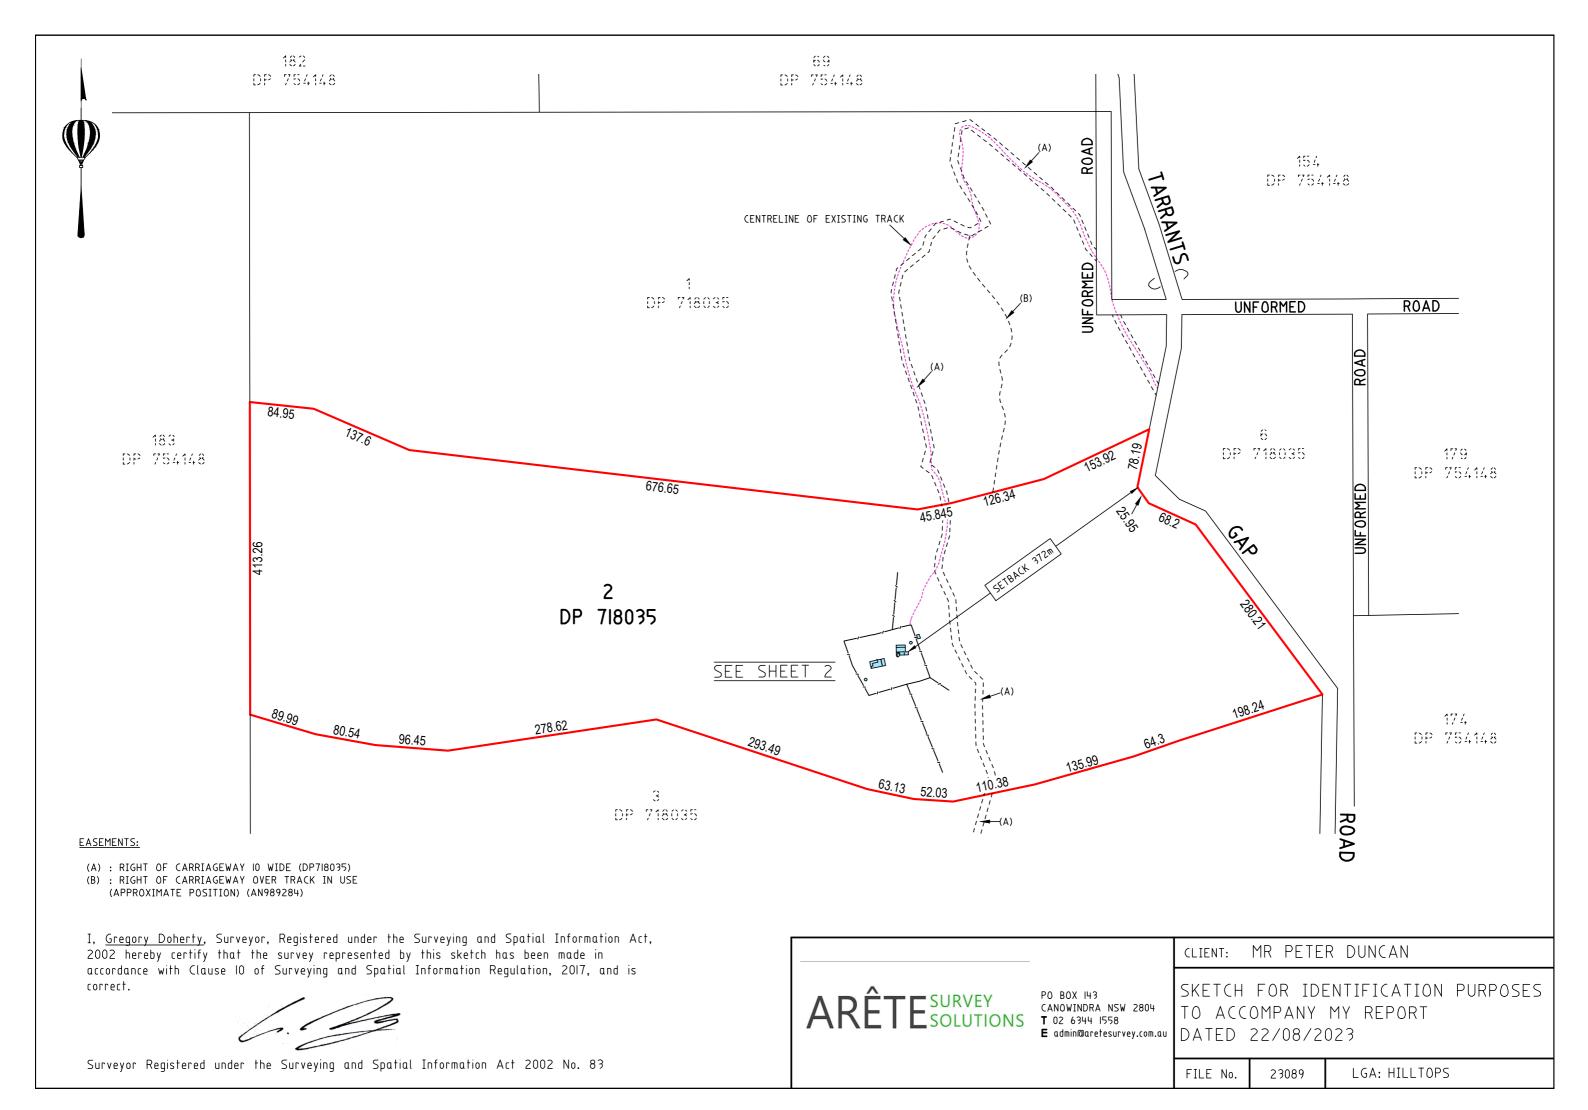

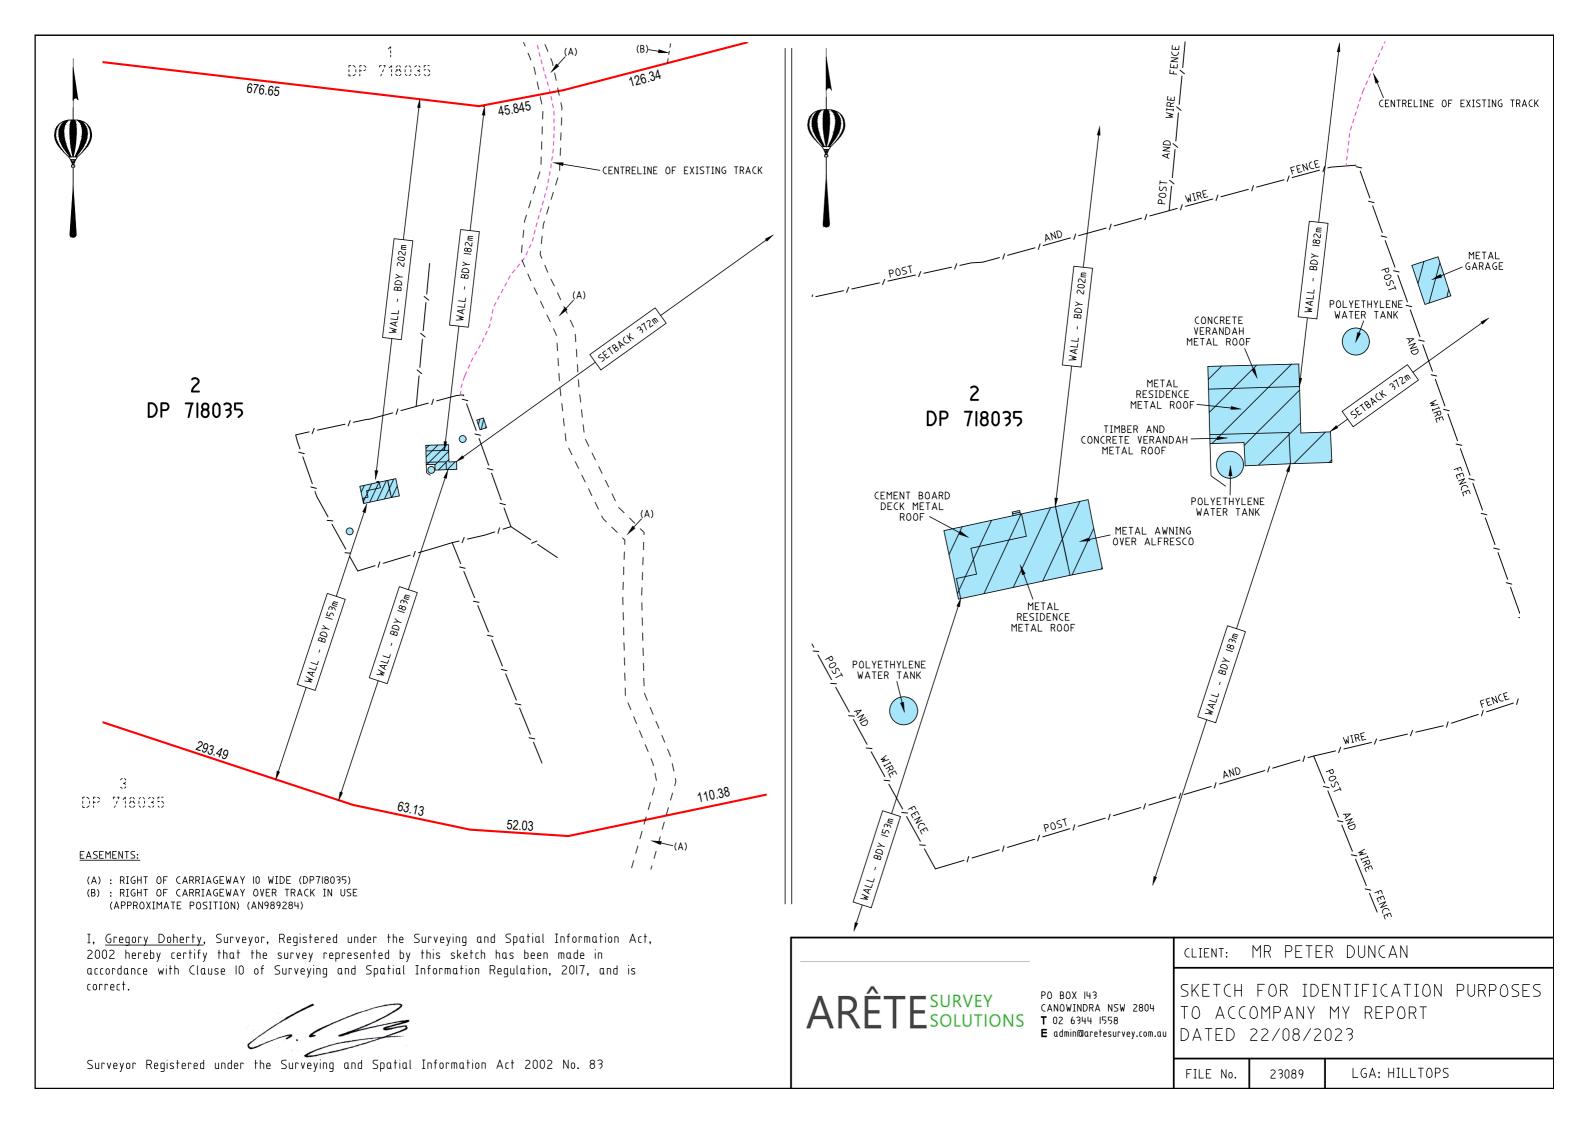


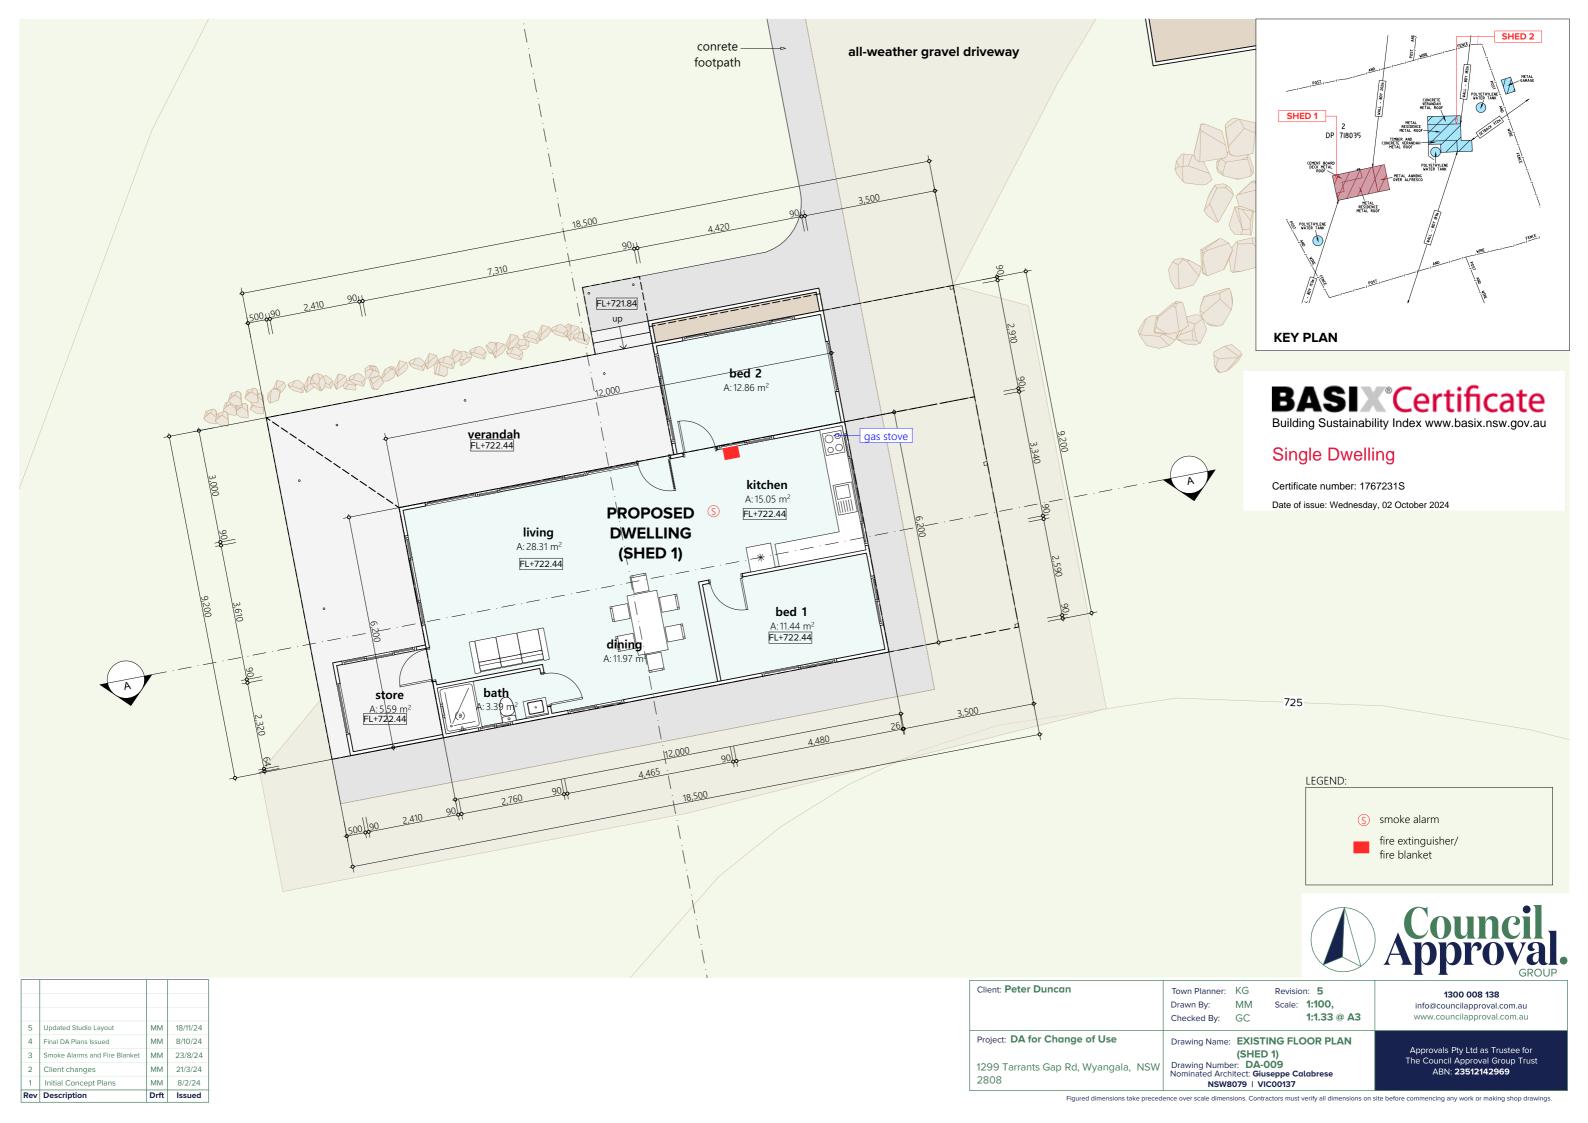







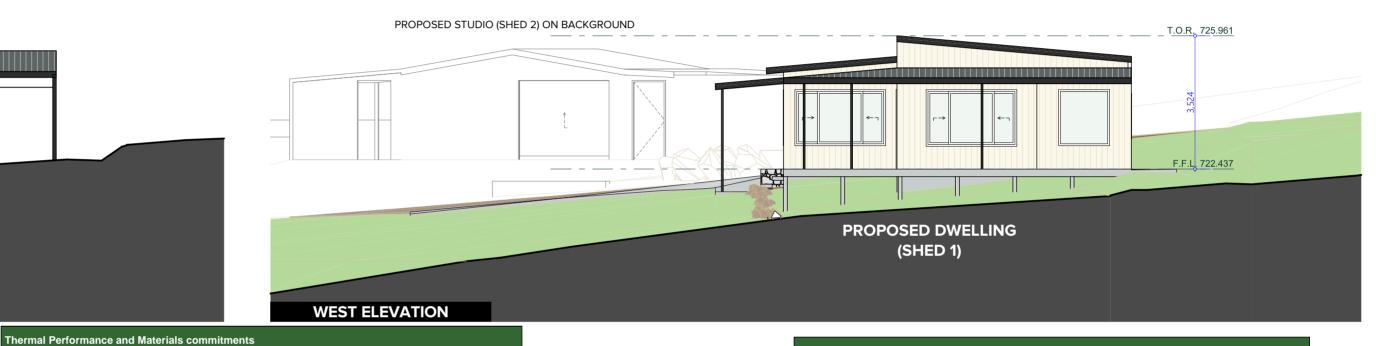

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MM 18/11/24

MM 8/10/24

MM 23/8/24

MM 21/3/24

4 Final DA Plans Issued

Client changes

Single Dwelling

Certificate number: 1767231S

Date of issue: Wednesday, 02 October 2024

ixtures	
the applicant must install showerheads with a minimum rating of 3 star (> 7.5 but <= 9 L/min) in all showers in the or	development.
he applicant must install a toilet flushing system with a minimum rating of 1 star in each toilet in the development.	
he applicant must install taps with a minimum rating of 3 star in the kitchen in the development.	
he applicant must install basin taps with a minimum rating of 3 star in each bathroom in the development.	
Alternative water	
lainwater tank	
he applicant must install a rainwater tank of at least 26000 litres on the site. This rainwater tank must meet, and be accordance with, the requirements of all applicable regulatory authorities.	e installed in
he applicant must configure the rainwater tank to collect rain runoff from at least 175 square metres of the roof are development (excluding the area of the roof which drains to any stormwater tank or private dam).	ea of the
he applicant must connect the rainwater tank to:	
all toilets in the development	
the cold water tap that supplies each clothes washer in the development	
 at least one outdoor tap in the development (Note: NSW Health does not recommend that rainwater be used for consumption in areas with potable water supply.) 	human
all hot water systems in the development	
all hot water systems in the development hermal Performance and Materials commitments	
hermal Performance and Materials commitments	
hermal Performance and Materials commitments o-it-yourself Method	
hermal Performance and Materials commitments	2 storeys.
hermal Performance and Materials commitments o-it-yourself Method eneral features	2 storeys.
hermal Performance and Materials commitments o-it-yourself Method eneral features ne dwelling must be a Class 1 dwelling according to the National Construction Code, and must not have more than	2 storeys.
hermal Performance and Materials commitments o-it-yourself Method eneral features ne dwelling must be a Class 1 dwelling according to the National Construction Code, and must not have more than the conditioned floor area of the dwelling must not exceed 300 square metres.	2 storeys.
hermal Performance and Materials commitments o-it-yourself Method eneral features ne dwelling must be a Class 1 dwelling according to the National Construction Code, and must not have more than the conditioned floor area of the dwelling must not exceed 300 square metres. The dwelling must not contain open mezzanine area exceeding 25 square metres.	2 storeys.
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Glazed windows, doors and skylights The applicant must install the windows, glazed doors and shading devices described in the table below, in accordance with the specifications listed in the table. Relevant overshadowing specifications must be satisfied for each glazed window and door. The dwelling may have 1 skylight (<0.7 square metres) which is not listed in the table. The following requirements must also be satisfied in relation to each window and glazed door: • The applicant must install windows and glazed doors in accordance with the height and width, frame and glazing types listed in the • Each window and glazed door must have a U- value no greater than that listed and a Solar Heat Gain Coefficient (SHGC) within the range listed. Total system U values and SHGC must be calculated in accordance with National Fenestration Rating Council (NFRC) conditions. The applicant must install the skylights described in the table below, in accordance with the specifications listed in the table. Total skylight area must not exceed 3 square metres (the 3 square metre limit does not include the optional additional skylight of less than 0.7 square metres that does not have to be listed in the table). Frame and glass North-East facing aluminium, single glazed (U-value: <=2.5, SHGC: eave 500 mm, 450 mm above head of window or 1400.00 1300.00 not overshadowed >0.18) glazed door aluminium, single glazed eave 500 mm, 450 mm not overshadowed (U-value: <=2.5, SHGC: >0.18) above head of window or glazed door South-East facing aluminium, single glazed (U-value: <=2.5, SHGC: eave 500 mm, 450 mm above head of window or W04 900.00 2000.00 not overshadowed >0.18) glazed door 1200.00 aluminium, single glazed (U-value: <=2.5, SHGC: eave 500 mm. 450 mm not overshadowed 1500.00 above head of window or >0.18) glazed door aluminium, single glazed (U-value: <=2.5, SHGC: 810.00 900.00 eave 500 mm, 450 mm above head of window or glazed door >0.18) South-West facing 1500.00 2400.00 aluminium, single glazed verandah 3000 mm, 2250 not overshadowed (U-value: <=2.5, SHGC: mm above base of window >0.18) or glazed door verandah 3000 mm, 2250 not overshadowed 1400.00 2400.00 (U-value: <=2.5, SHGC: mm above base of window

aluminium, single glazed (U- verandah 3000 mm, 2250 not overshadowed

mm above base of window

eave 500 mm, 500 mm

above head of window or glazed door

verandah 3000 mm, 2250 not overshadowed

not overshadowed

or glazed door

value: <=2.5, SHGC: >0.6) mm above base of window

aluminium, single glazed (U-value: <=2.5, SHGC:

aluminium, single glazed

(U-value: <=2.5, SHGC: >0.33)

North-West facing

W12

1400.00

1400.00

1400.00

5700.00

2000.00

3000.00


Hot v	vater
	oplicant must install the following hot water system in the development, or a system with a higher energy rating: gas taneous with a performance of 6.5 stars.
Cool	ing system
The liv	ing areas must not incorporate any cooling system, or any ducting which is designed to accommodate a cooling system.
The be	edrooms must not incorporate any cooling system, or any ducting which is designed to accommodate a cooling system.
Heati	ing system
The liv	ing areas must not incorporate any heating system, or any ducting which is designed to accommodate a heating system
The be	edrooms must not incorporate any heating system, or any ducting which is designed to accommodate a heating system.
Venti	lation
The ap	oplicant must install the following exhaust systems in the development:
At le	ast 1 Bathroom: no mechanical ventilation (ie. natural); Operation control: n/a
Kitch	en: individual fan, open to façade; Operation control: manual switch on/off
Laur	dry: natural ventilation only, or no laundry; Operation control: n/a
Artifi	cial lighting
	oplicant must ensure that a minimum of 80% of light fixtures are fitted with fluorescent, compact fluorescent, or light-emit (LED) lamps.
Natu	ral lighting
The ap	oplicant must install a window and/or skylight in 1 bathroom(s)/toilet(s) in the development for natural lighting.
Othe	
The ap	oplicant must install a gas cooktop & electric oven in the kitchen of the dwelling.
	oplicant must install a fixed outdoor clothes drying line as part of the development.


				Council Approval.	
nt: Peter Duncan	Town Planner:	KG MM	Revision: 5	1300 008 138	

Client: Peter Duncan	Town Planner: KG Drawn By: MI Checked By: GG	M Scale: 1:100 ,	1300 008 138 info@councilapproval.com.au www.councilapproval.com.au
Project: DA for Change of Use		HED 1 EXISTING	Approvals Pty Ltd as Trustee for
1299 Tarrants Gap Rd, Wyangala, NSW 2808	ELEVATIONS Drawing Number: DA-010 Nominated Architect: Giuseppe Calabrese NSW8079 VIC00137		The Council Approval Group Trust ABN: 23512142969

NSW8079 | VIC00137

Figured dimensions take precedence over scale dimensions. Contractors must verify all dimensions on site before commencing any work or making shop drawin

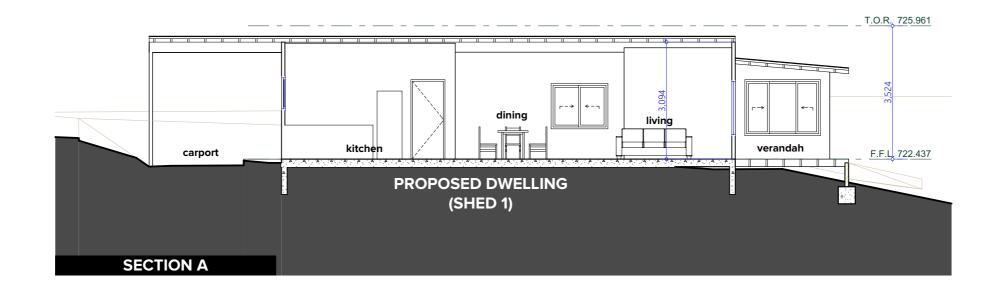

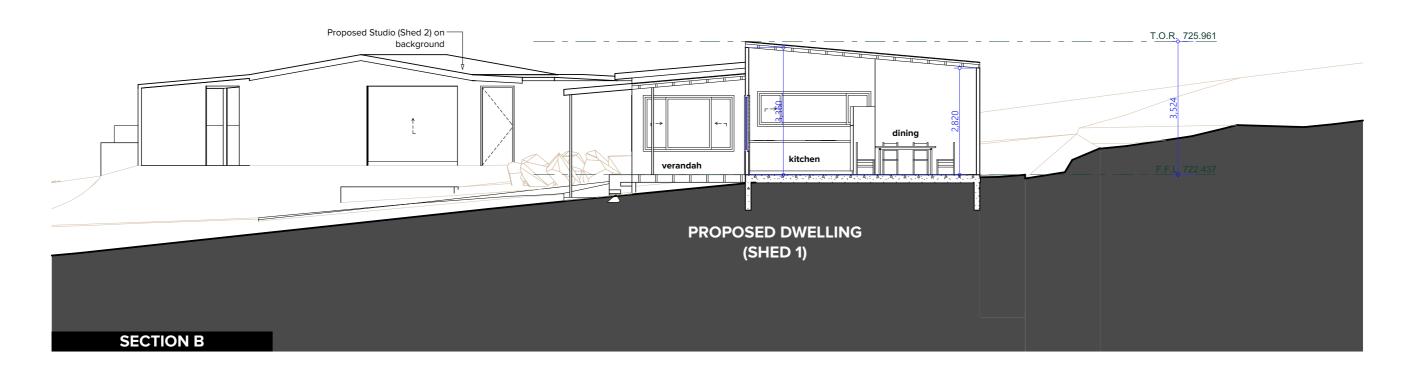

Construction	Area - m²	Additional insulation required	Options to address thermal bridging	Other specifications
floor - concrete slab on ground, waffle pod slab.	88.61	nil;not specified	nil	
external wall: framed (metal clad); frame: light steel frame.	all external walls	3.50 (or 4.00 including construction) with one of the measures to address thermal bridging; rockwool batts, roll or pump-in	Install reflective foil outside the frame to create a minimum 20 mm reflective airspace between frame and veneer, or • Install continuous insulation layer with at least R0.3 on the inside or outside of the frame	wall colour: Light (solar absorptance < 0.48)
internal wall: plasterboard; frame: light steel frame.	48.84	rockwool batts, roll or pump-in	nil	
ceiling and roof - flat ceiling / flat roof, framed - metal roof, light steel frame.	175	ceiling: 6.4 (up), roof: foil/sarking with the measure to address thermal bridging;ceiling: rockwool batts, roll or pump-in; roof: foil/ sarking.	Install continuous insulation layer with at least R0.6 above or below the roof frame members	roof colour: medium (solar absorptance 0.48-0.59); 0.5 to ≤ 1.0% of ceiling area uninsulated
		·		

5	Updated Studio Layout	MM	18/11/24
4	Final DA Plans Issued	MM	8/10/24
3	Smoke Alarms and Fire Blanket	MM	23/8/24
2	Client changes	MM	21/3/24
1	Initial Concept Plans	MM	8/2/24
Rev	Description	Drft	Issued

Note	Insulation specified in this Certificate must be installed in accordance with the ABCB Housing Provisions (Part 13.2.2) of the National Construction Code.	Client: Peter Duncan	Γ.
Note	If the additional ceiling insulation listed in the table above is greater than R3.0, refer to the ABCB Housing Provisions (Part 13.2.3 (6)) of the National Construction Code.		1
Note	In some climate zones, insulation should be installed with due consideration of condensation and associated interaction with adjoining building materials.		Ľ
Note	Roof space ventilation needs to meet the condensation management provisions in the ABCB Housing Provisions of the National Construction Code.	Project: DA for Change of Use	1
Note	Thermal breaks must be installed in metal framed walls and applicable roofs in accordance with the ABCB Housing Provisions of the National Construction Code.	1299 Tarrants Gap Rd, Wyangala, NSW	1
		2808	1



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Single Dwelling

Certificate number: 1767231S

Date of issue: Wednesday, 02 October 2024




	Client: Peter Duncan	Town Planner: Drawn By: Checked By:	MM	Revision: 5 Scale: 1:100, 1:1.33 @ A3
4	Project: DA for Change of Use	Drawing Namo:	SHED	1 EXISTING SECTION


Drawing Name: SHED 1 EXISTING SECTION

Drawing Number: DA-011 Nominated Architect: Giuseppe Calabrese NSW8079 | VIC00137 Approvals Pty Ltd as Trustee for The Council Approval Group Trust ABN: 23512142969

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Water Commitments				
Fixtures				
The applicant must install showerheads with a minimum rating of 3 star (> 7.5 but <= 9 L/min) in all showers in the development.				
The applicant must install a toilet flushing system with a minimum rating of 1 star in each toilet in the development.				
The applicant must install taps with a minimum rating of 3 star in the kitchen in the development.				
The applicant must install basin taps with a minimum rating of 3 star in each bathroom in the development.				
Alternative water				
Rainwater tank				
The applicant must install a rainwater tank of at least 26000 litres on the site. This rainwater tank must meet, and be installed in accordance with, the requirements of all applicable regulatory authorities.				
The applicant must configure the rainwater tank to collect rain runoff from at least 158.13 square metres of the roof area of the development (excluding the area of the roof which drains to any stormwater tank or private dam).				
The applicant must connect the rainwater tank to:				
all toilets in the development				
the cold water tap that supplies each clothes washer in the development				
 at least one outdoor tap in the development (Note: NSW Health does not recommend that rainwater be used for human consumption in areas with potable water supply.) 				
all hot water systems in the development				

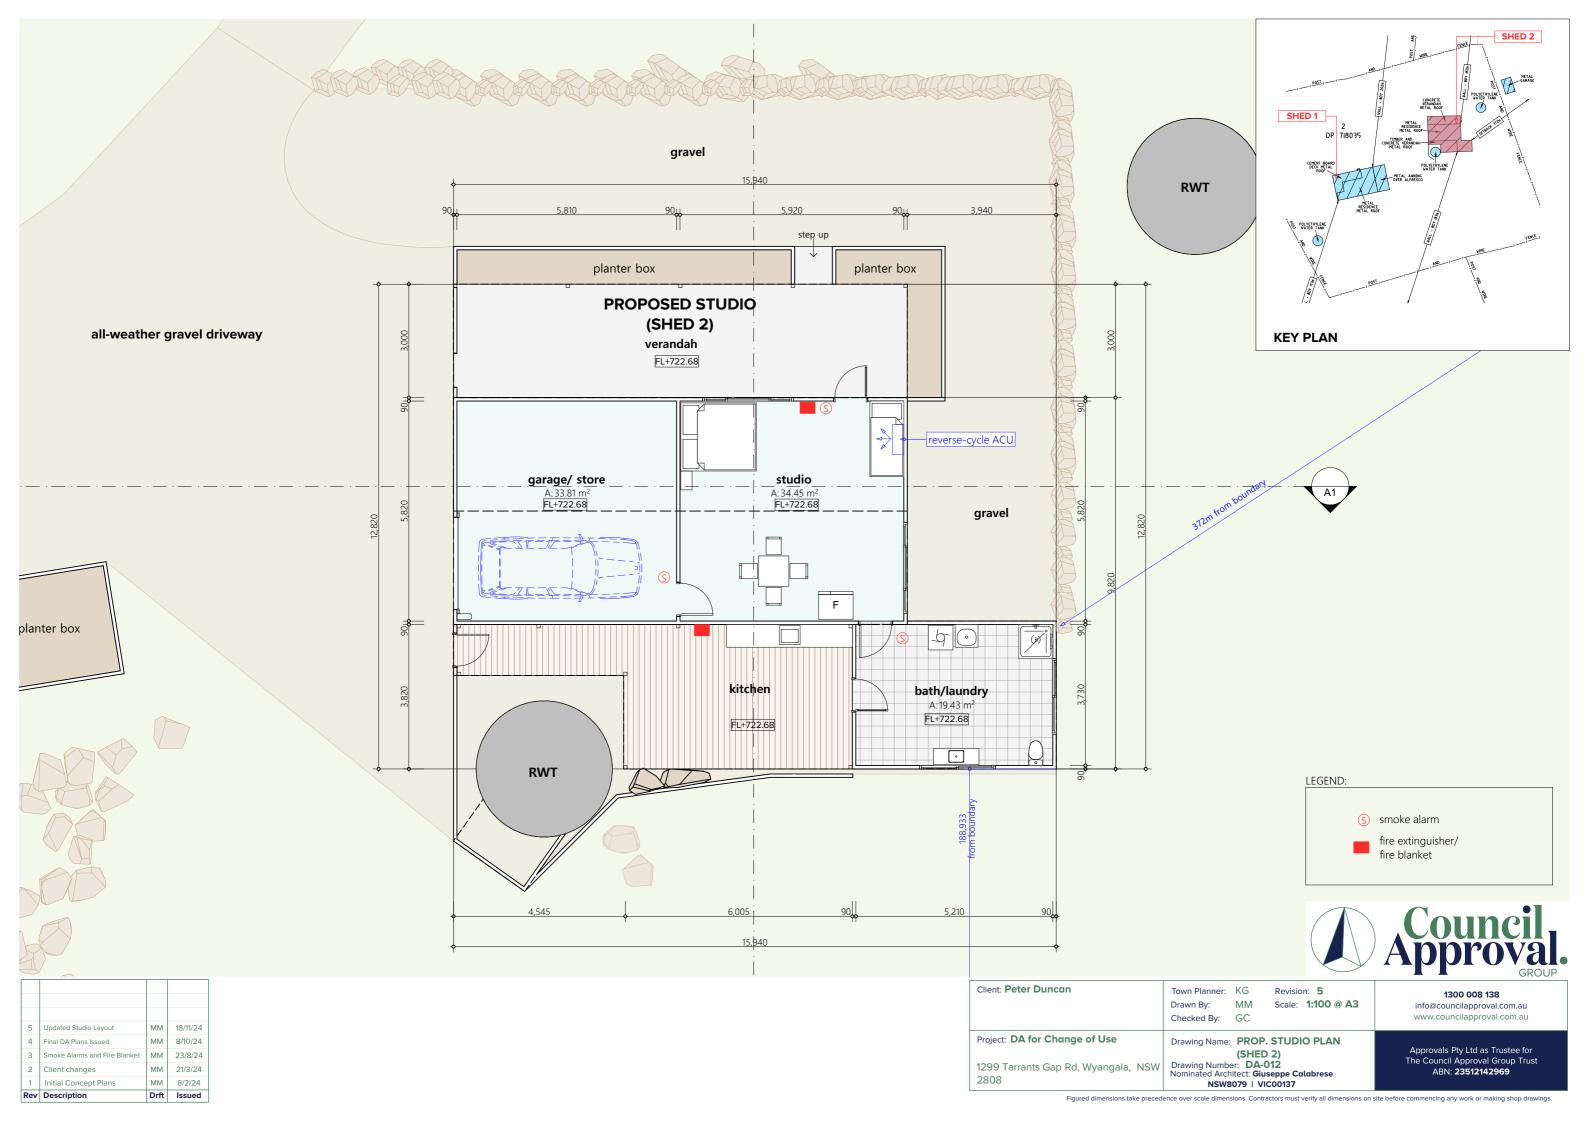Thermal Performance and Materials commitments
Do-it-yourself Method
General features
The dwelling must be a Class 1 dwelling according to the National Construction Code, and must not have more than 2 storeys.
The conditioned floor area of the dwelling must not exceed 300 square metres.
The dwelling must not contain open mezzanine area exceeding 25 square metres.
The dwelling must not contain third level habitable attic room.
Floor, walls and ceiling/roof
The applicant must construct the floor(s), walls, and ceiling/roof of the dwelling in accordance with the specifications listed in the tal below.
The applicant must adopt one of the options listed in the tables below to address thermal bridging in metal framed floor(s), walls an ceiling/roof of the dwelling.

Rev Description

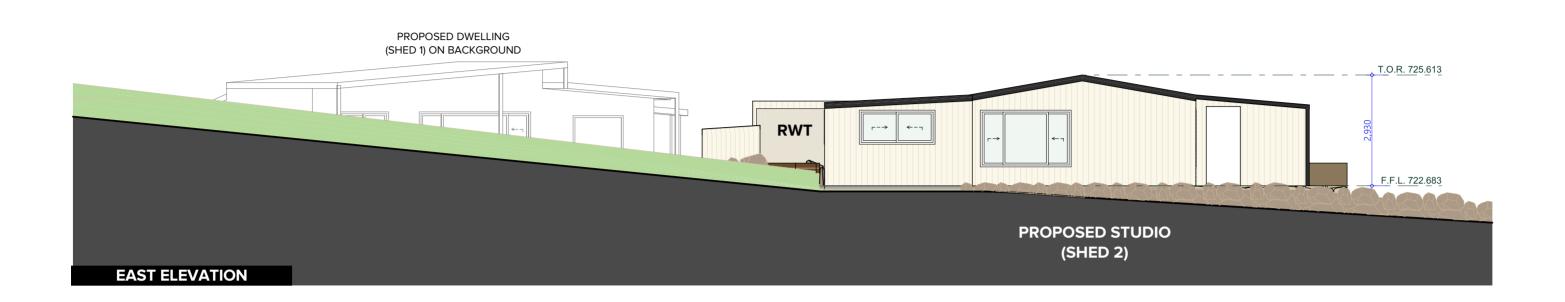Construction	Area - m²	Additional insulation required	Options to address thermal bridging	Other specifications
floor - concrete slab on ground, waffle pod slab.	53.88	nil;not specified	nil	
garage floor - concrete slab on ground.	33.81	none	nil	

Construction	Area - m²	Additional insulation required	Options to address thermal bridging	Other specifications
external wall: framed (metal clad); frame: light steel frame.	all external walls	3.50 (or 4.00 including construction) with one of the measures to address thermal bridging:rockwool batts, roll or pump-in	Install reflective foil outside the frame to create a minimum 20 mm reflective airspace between frame and veneer, or • Install continuous insulation layer with at least RO.3 on the inside or outside of the frame	wall colour: Light (solar absorptance < 0.48)
nternal wall: plasterboard; frame: ight steel frame.	16.8	rockwool batts, roll or pump-in	nil	
ceiling and roof - flat ceiling / flat roof, framed - metal roof, light steel frame.	158	ceiling: 6.4 (up), roof: foil/sarking with the measure to address thermal bridging;ceiling: rockwool batts, roll or pump-in; roof: foil/ sarking.	Install continuous insulation layer with at least R0.6 above or below the roof frame members	roof colour: medium (solar absorptance 0.48-0.59); 0.5 to \leq 1.0% of ceiling area uninsulated

L		
	Note	Insulation specified in this Certificate must be installed in accordance with the ABCB Housing Provisions (Part 13.2.2) of the National Construction Code.
	Note	If the additional ceiling insulation listed in the table above is greater than R3.0, refer to the ABCB Housing Provisions (Part 13.2.3 (6)) of the National Construction Code.
	Note	In some climate zones, insulation should be installed with due consideration of condensation and associated interaction with adjoining building materials.
	Note	Roof space ventilation needs to meet the condensation management provisions in the ABCB Housing Provisions of the National Construction Code.
	Note	• Thermal breaks must be installed in metal framed walls and applicable roofs in accordance with the ABCB Housing Provisions of the National Construction Code.

Glazed window/door no.	Maximum height (mm)	Maximum width (mm)	Frame and glass specification	Shading device (Dimension within 10%)	Overshadowing
North facing					
W01	1500.00	2400.00	aluminium, single glazed (U-value: <=2.5, SHGC: >0.18)	verandah 3000 mm, 2200 mm above base of window or glazed door	not overshadowed
East facing					
W02	1500.00	2400.00	thermally broken aluminium, single glazed (U-value: <=2, SHGC: >0.4)	none	not overshadowed
W03	900.00	2000.00	aluminium, single glazed (U-value: <=2.5, SHGC: >0.18)	none	not overshadowed

Thermal Performance and Materials commitments

The applicant must install the windows, glazed doors and shading devices described in the table below, in accordance with the specifications listed in the table. Relevant overshadowing specifications must be satisfied for each glazed window and door. The dwelling may have 1 skylight (<0.7 square metres) which is not listed in the table.

The following requirements must also be satisfied in relation to each window and glazed door:

The applicant must install windows and glazed doors in accordance with the height and width, frame and glazing types listed in the

Each window and glazed door must have a U- value no greater than that listed and a Solar Heat Gain Coefficient (SHGC) within the range listed. Total system U values and SHGC must be calculated in accordance with National Fenestration Rating Council (NFRC) conditions.

The applicant must install the skylights described in the table below, in accordance with the specifications listed in the table. Total skylight area must not exceed 3 square metres (the 3 square metre limit does not include the optional additional skylight of less than 0.7 square metres that does not have to be listed in the table).

Cooling system
The applicant must install the following cooling system, or a system with a higher energy rating, in at least 1 living area: 1-phase airconditioning - non ducted; Energy rating: 3 Star (old label)
The applicant must install the following cooling system, or a system with a higher energy rating, in at least 1 bedroom: 1-phase airconditioning - non ducted; Energy rating: 1 star (cold zone)
Heating system
The applicant must install the following heating system, or a system with a higher energy rating, in at least 1 living area: 1-phase airconditioning - non ducted; Energy rating: 3 star (cold zone)
The applicant must install the following heating system, or a system with a higher energy rating, in at least 1 bedroom: 1-phase airconditioning - non ducted; Energy rating: 3 star (cold zone)
Ventilation
The applicant must install the following exhaust systems in the development:
At least 1 Bathroom: no mechanical ventilation (ie. natural); Operation control: n/a

Kitchen: individual fan, open to façade; Operation control: manual switch on/off

The applicant must install the following hot water system in the development, or a system with a higher energy rating: gas instantaneous with a performance of 4 stars.

Laundry: natural ventilation only, or no laundry; Operation control: n/a Artificial lighting

The applicant must ensure that a minimum of 80% of light fixtures are fitted with fluorescent, compact fluorescent, or light-emitting-diode (LED) lamps.

The applicant must install a window and/or skylight in 1 bathroom(s)/toilet(s) in the development for natural lighting.

The applicant must install a window and/or skylight in the kitchen of the dwelling for natural lighting.

The applicant must install a fixed outdoor clothes drying line as part of the development.

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Single Dwelling


Energy Commitments


Hot water

Certificate number: 1767230S Date of issue: Wednesday, 02 October 2024



Client: Peter Duncan	Client: Peter Duncan Town Planner: KG Revision: 5
	Drawn By: MM Scale: 1:100,
	Checked By: GC 1:1.59 @ A2
Project: DA for Change of Use	Project: DA for Change of Use Drawing Name: PROP. STUDIO SHED 2
	ELEVATIONS
	1299 Tarrants Gap Rd, Wyangala, NSW Drawing Number: DA-013 Nominated Architect: Giuseppe Calabrese
2808	2808 NSW8079 VIC00137
Figured dimensions take pr	Figured dimensions take precedence over scale dimensions. Contractors must verify all dimensions or

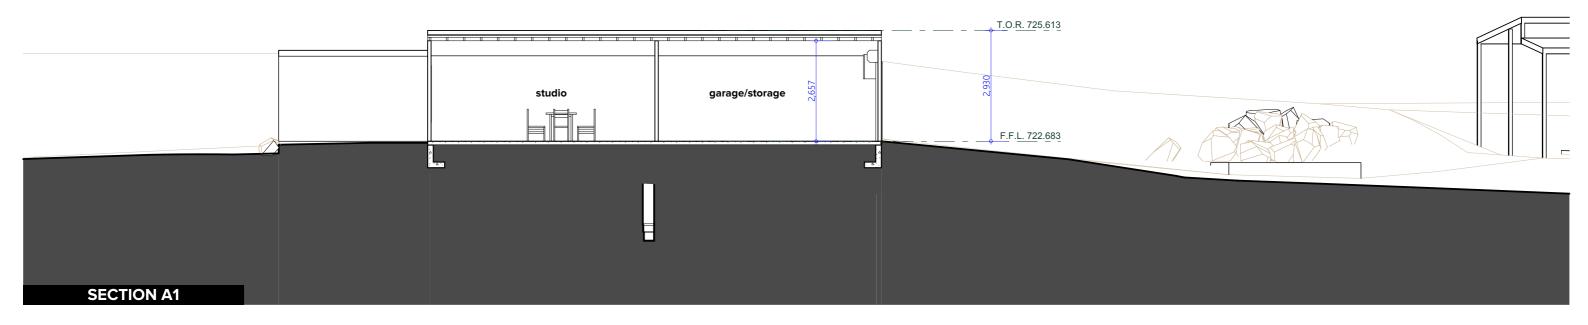

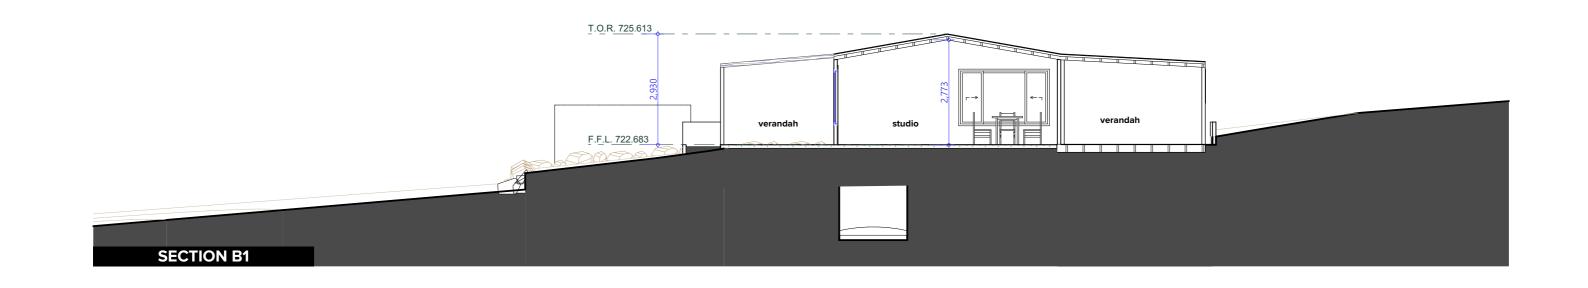



				01(00)
Client: Peter Duncan	Town Planner: Drawn By: Checked By:	KG MM GC	Revision: 5 Scale: 1:100 @ A3	1300 008 138 info@councilapproval.com.au www.councilapproval.com.au
Project: DA for Change of Use 1299 Tarrants Gap Rd, Wyangala, NSW	Drawing Numb	SECTI er: DA-0		Approvals Pty Ltd as Trustee for The Council Approval Group Trust ABN: 23512142969
2808	NSW8	3079 ∣ VI	C00137	

Rev	Description	Drft	Issued
1	Initial Concept Plans	MM	8/2/24
2	Client changes	MM	21/3/24
3	Smoke Alarms and Fire Blanket	MM	23/8/24
4	Final DA Plans Issued	MM	8/10/24
5	Updated Studio Layout	MM	18/11/24







		Council Approval.	
Client: Peter Duncan	Town Planner: KG Revision: 5 Drawn By: MM Scale: 1:158.75 @ Checked By: GC A3	1300 008 138 info@councilapproval.com.au www.councilapproval.com.au	
Project: DA for Change of Use 1299 Tarrants Gap Rd, Wyangala, NSW	Drawing Name: PROPOSED 3D IMAGES (1) Drawing Number: DA-015 Nominated Architect: Giuseppe Calabrese	Approvals Pty Ltd as Trustee for The Council Approval Group Trust ABN: 23512142969	
1299 Tarrants Gap Rd, Wyangala, NSW 2808			







Rev	Description	Drft	Issued
1	Initial Concept Plans	MM	8/2/24
2	Client changes	MM	21/3/24
3	Smoke Alarms and Fire Blanket	MM	23/8/24
4	Final DA Plans Issued	MM	8/10/24
5	Updated Studio Layout	MM	18/11/24

Client: Peter Duncan	Town Planner: KG Drawn By: MI Checked By: GG	M Scale: 1:158	3. 75 @	1300 008 138 info@councilapproval.com.au www.councilapproval.com.au
Project: DA for Change of Use	Drawing Name: PROPOSED 3D IMAGES (2)			Approvals Pty Ltd as Trustee for
1299 Tarrants Gap Rd, Wyangala, NSW 2808	Drawing Number: DA-016 Nominated Architect: Giuseppe Calabrese NSW8079 VIC00137			The Council Approval Group Trust ABN: 23512142969

NSW8079 | VIC00137